



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Α	REVISED SCHEME	14-07-2020	AG
В	MINOR AMENDMENTS	24-07-2020	AG
С	MINOR AMENDMENTS	12-01-2021	AG
D	MINOR AMENDMENTS	03-03-2021	AG
E	MINOR AMENDMENTS	22-07-2021	AG
	0 1 2 3 4 5 6 7	8	9 10
SCALE	metres		

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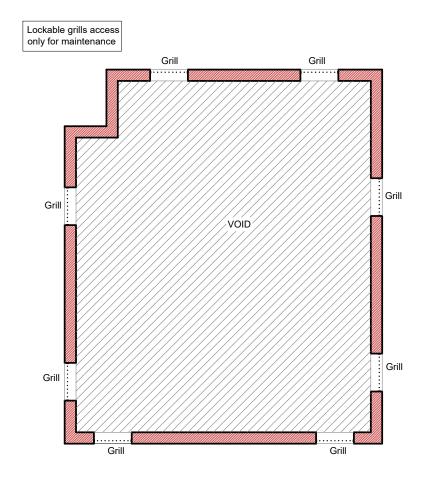
LAND ADJACENT 17-20, TUDOR COURT, LONDON E17 8ET	JUNE 2020	
PROPOSED CONSTRUCTION OF 1No. 3 BEDROOM HOUSE	scale 1:100 (atA3)	
	dwn by A.G	
drawing title PROPOSED GROUND FLOOR PLAN	drg.no REV. 270-20E	
BLUELINE	I	
ARCHITECTURAL CONSULTANTS LIMITED 20 THE TRAMWORKS, HATHERLEY MEWS, LONDON E17 4QP	t: 020 8521 0158 e: bluelinelondon@gmail.co	

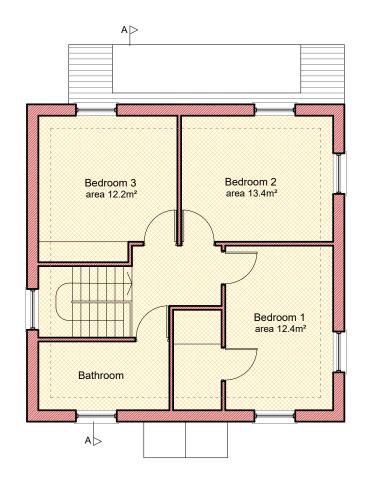


PROPOSED FIRST FLOOR PLAN



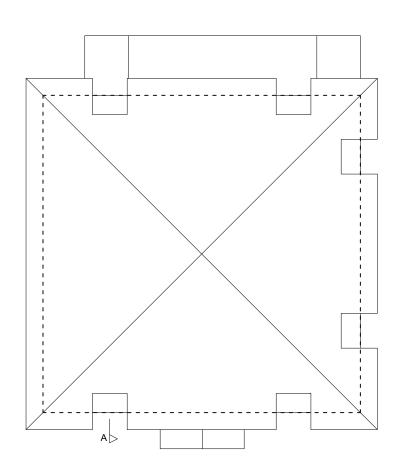PROPOSED ROOF PLAN




PROPOSED LOWER GROUND FLOOR PLAN

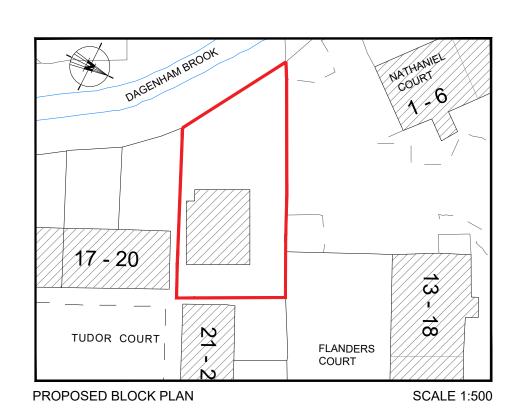


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A	REVISED SCHEME	14-07-2020	
В	MINOR AMENDMENTS	24-07-2020	AG
С	MINOR AMENDMENTS	12-01-2021	AG
E	MINOR AMENDMENTS	22-07-2021	AG
	0 1 2 3 4 5 6 7	8	9 10
SCALE	metres		

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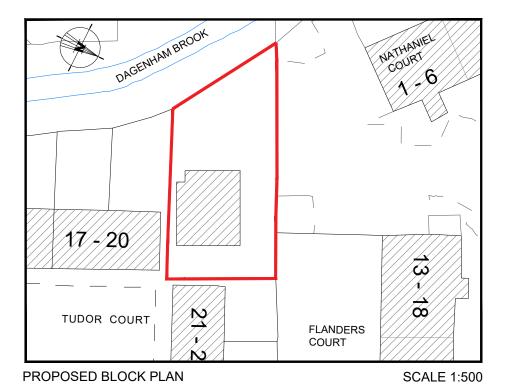
address LAND ADJACENT 17-20, TUDOR COURT, LONDON E17 8ET	JUNE 2020
project description PROPOSED CONSTRUCTION OF 1No. 3 BEDROOM HOUSE	scale 1:100 (atA3)
	dwn by A.G
drawing title PROPOSED FLOOR PLANS	drg.no REV. 270-21E
BLUELINE	I
ARCHITECTURAL CONSULTANTS LIMITED 20 THE TRAMWORKS, HATHERLEY MEWS, LONDON E17 4QP	t: 020 8521 0158 e: bluelinelondon@gmail.co

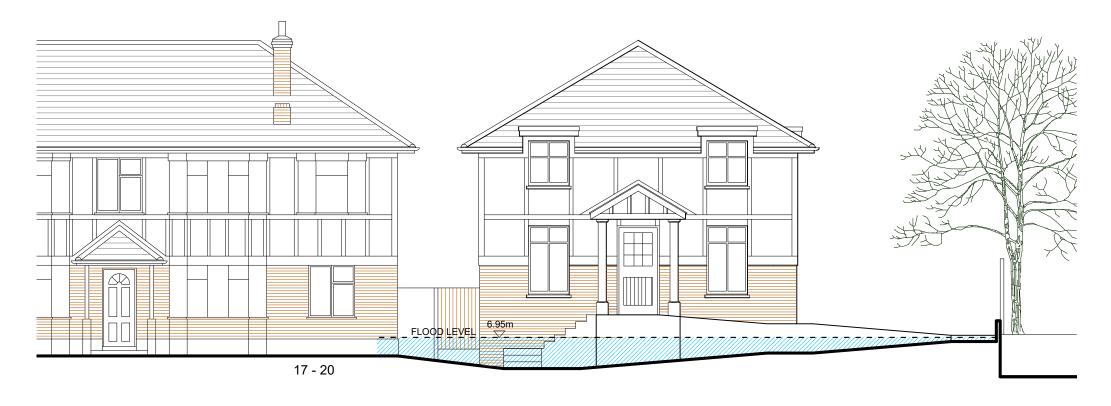

## PROPOSED FRONT ELEVATION

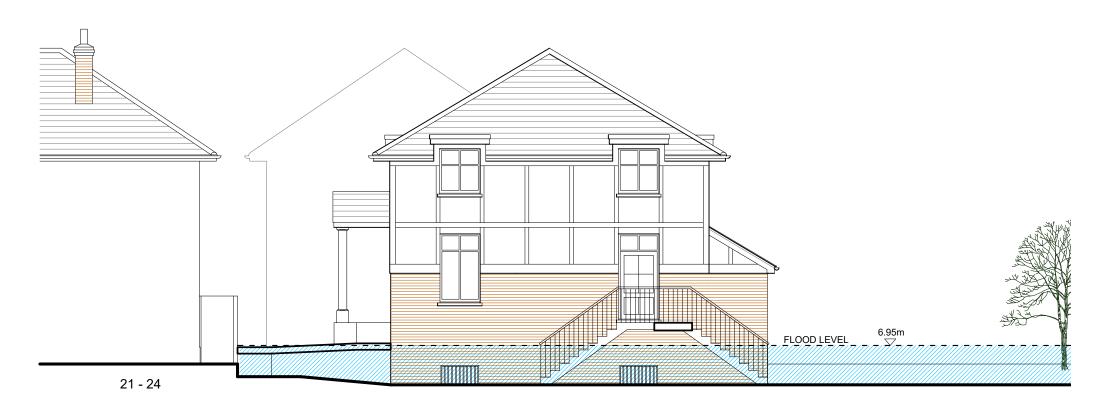

## PROPOSED SIDE ELEVATION




REV	DESCRIPTION								E	BY
A B C D	MINOR AME RELABELLE BOUNDARY	MINOR AMENDMENTS RELABELLED DRAWING							) A	G G G
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Location Plan

Nannanie Court

address LAND ADJACENT 17-20, TUDOR COURT, LONDON E17 8ET	JUNE 2020
PROPOSED CONSTRUCTION OF 1No. 3 BEDROOM HOUSE	1:100 (atA3)
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PROPOSED ELEVATIONS	270-22E
BLUELINE	'
ARCHITECTURAL CONSULTANTS LIMITED	t: 020 8521 0158 e: bluelinelondon@gmail.co


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#### PROPOSED SIDE ELEVATION

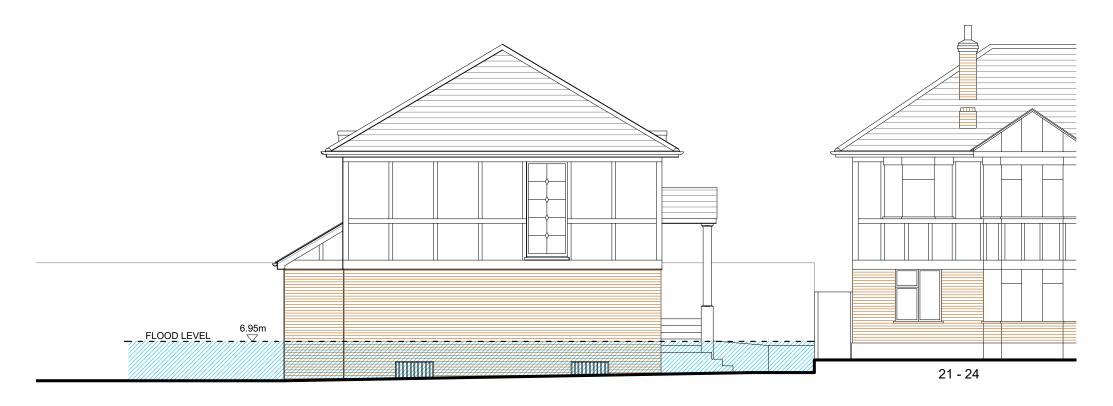

### PROPOSED REAR ELEVATION



## PROPOSED SECTION A-A
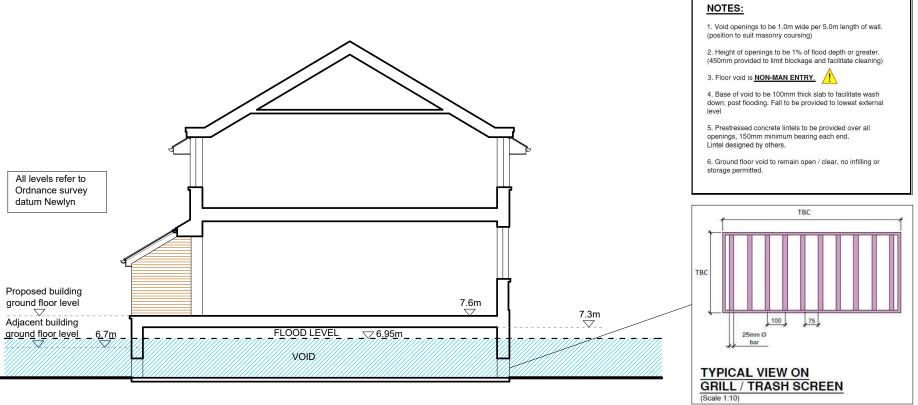
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REV	DESCRIPTION	DATE	BY
A B C	REVISED SCHEME MINOR AMENDMENTS RELABELLED DRAWING	14-07-2020 24-07-2020 10-08-2020	AG
Е	MINOR AMENDMENTS	22-07-2021	AG
SCALE	0 1 2 3 4 5 6 7 metres	8	9 10

а	ıddress	
	AND AD	

LAND ADJACENT 17-20, TUDOR COURT, LONDON E17 8ET

project description

PROPOSED CONSTRUCTION OF 1No. 3 BEDROOM HOUSE

PROPOSED ELEVATIONS & SECTION

# **JUNE 2020**

scale (atA3) 1:100 dwn by

A.G drg.no REV.


270-23E

# BLUELINE

ARCHITECTURAL CONSULTANTS LIMITED

t: 020 8521 0158 e: bluelinelondon@gmail.com

20 THE TRAMWORKS, HATHERLEY MEWS, LONDON E17 4QP

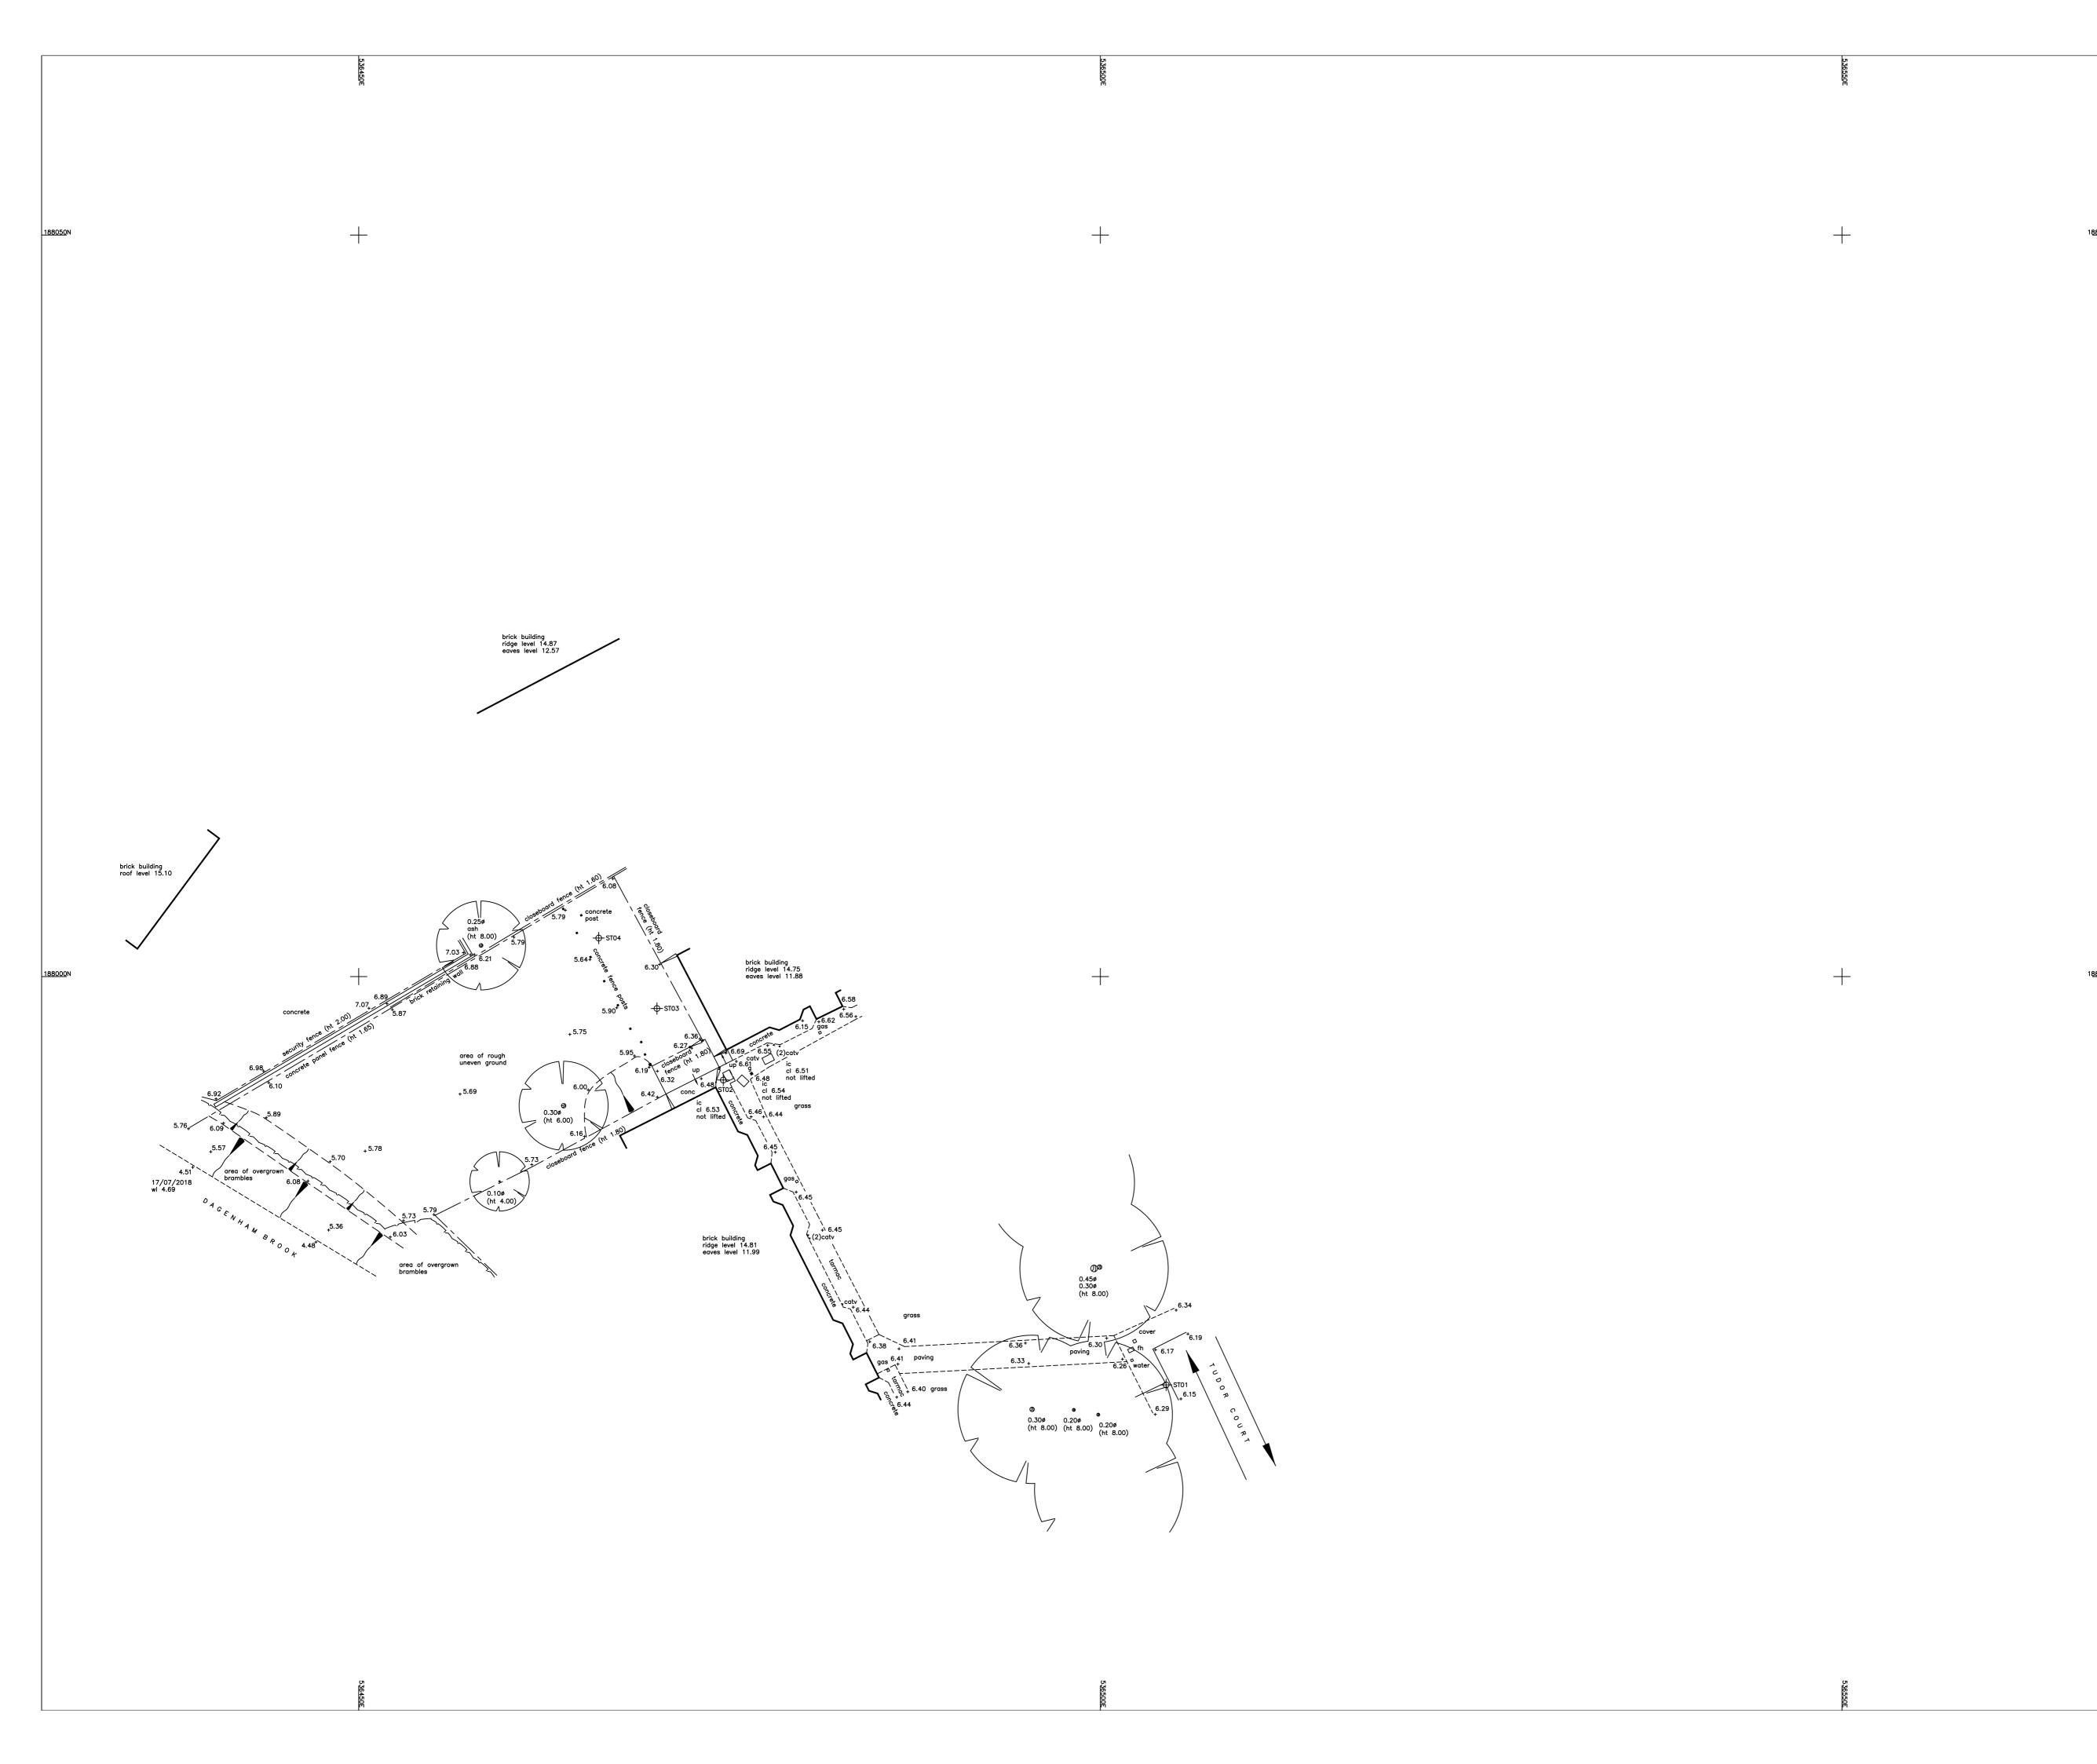

#### **NOTES**

GENERAL NOTES :-

ALL LEVELS ARE IN METRES DERIVED FROM GPS TRANSFORMATION. GRID COORDINATES ARE ORDNANCE SURVEY NATIONAL GRID DERIVED FROM GPS TRANSFORMATION. GPS COORDINATES AND LEVELS SET AT STO1 (NO SCALE FACTOR APPLIED)

THIS DRAWING HAS BEEN PRODUCED WITH A PLOT SCALE ACCURACY OF 1:200

SERVICE COVERS INDICATED WHERE VISIBLE. PIPE INVERTS / DETAILS SURVEYED FROM SURFACE INSPECTION ONLY. GENERALLY DAMAGED COVERS AND COVERS WITHIN HIGHWAYS WILL NOT BE LIFTED TREE SPECIES SHOULD BE CONFIRMED BY TREE SPECIALIST IF CRITICAL.

OVERHEAD CABLES ARE INDICATED USING REMOTE SURVEY METHODS AND ARE SUBJECT TO SEASONAL VARIATION, AND SHOULD BE TREATED AS APPROXIMATE. SERVICE COVERS LOCATED UNDER PARKED VEHICLES/MOBILE STRUCTURES MAYBE OMITTED. 188050N BURIED SERVICE COVERS WILL NOT BE INDICATED.

#### TOPOGRAPHICAL SURVEY/UTILITY KEY :-

ol — off let
osa — off survey area
OSBM — ordnance survey bench mark
p & r fence — post & rail fence
pd — pit depth
pr — pipe riser
ptg — pipe to ground
pts — pipe to surface
re — rodding eye
ret wall — retaining wall
rs — road sign
rwp — rain water pipe
s/birch — silver birch
s/p — safety paving
sap — sapling
sec fence — security fence
sfc — soil filled chamber
sl — spot light
sp — soil pipe
st — stop tap
sv — stop valve
svp — soil vent pipe
sws — storm water sewer
TBM — temporary bench mark
tfr — taken from records
tl — threshold level
toc — top of cap
top — top of pipe
tot — top of tank
tp — telecom pole
ts — traffic signal
t/s — trench scar
u/s — underside
utl — unable to lift
utr — unable to rod
uts — unable to trace
vp — vent pipe
wfc — water filled chamber
wl — water level
wm — water meter
wp — waste pipe
wr — water riser (ht) — height
Ø — diameter
Ø — pea trap
a/g — above ground
a/r — assumed route
av — air valve
bb — belisha beacon
bd — back drop
bl — bed level
boll — bollard
bos — bottom of shaft
bt — telecom
c/b fence — closeboard fence c/b fence — closeboard fence
c/box — control box
catv — cable television
cl — cover level
con — conifer
cr — cable riser
cws — combined water sewer
d/chan — drainage channel
ejb — electric junction box
elec — electric
eot — end of trace
ep — electric pole
er — earth rod
f/bed — flower bed
fh — fire hydrant
fl — floor level
fs — fire switch
fws — foul water sewer
g — gully
g/run — gully run
gr — gas riser
h/chestnut — horse chestnut
h/thorn — hawthorn
ic — inspection cover n/thorn — hawthorn
ic — inspection cover
il — invert level
ill — illuminated
int — interceptor
lp — lamp post
mh — manhole cover
mkr — marker
o/h — over head

ORTHINGS LEVE	ĒL
7972.468 6.25	54
7993.025 6.54	49
7997.846 6.14	43
8002.598 5.88	39
	17972.468 6.29 17993.025 6.54 17997.846 6.14



— AR — AR — ASSUMED ROUTE
— TFR — TFR — TAKEN FROM RECORDS

NORTH POINT :-

### UTILITY SURVEY KEY :-

HATCHED AREA BOREHOLE TRIAL PIT

# DISCLAIMER :-

Electromagnetic techniques have been used in the location of underground services. The results are not infallible and trial excavations should be carried out to confirm service identification, positions and particularly depths, where these are critical. The completeness of the underground services information cannot be guaranteed. This method of survey does not differentiate between live and dead services, and as such all services should be treated as live. This drawing may not include the location of all public services that may cross the site, therefore the relevant service drawings should be obtained from the appropriate utility company and used in conjunction with this drawing.


Private service pipes and cables in highways are not shown, but there presence should be anticipated.  $\,$ Additional below ground structures or obstructions not shown on this drawing may be present. Reference should be made to historical plans and as—built drawings. Excavations in the vicinity of services should be carried out with due diligence ref: HSG47 document avoiding dangers from underground services Please note that factors such as ground conditions, proximity of other utilities, material and method of construction have an influence on the quality of the data collected on site.

TSA Standards — "Even an appropriate and professionally executed survey may not be able to achieve a 100% detection rate."

# **UTILITY NOTES**

# **MIDLAND SURVEY LTD**

Cromwell House, Westfield Road, Southam, Warwickshire, CV47 0JH. Tel: 01926 810811 Fax 01926 810812 E-Mail: mail@midlandsurvey.co.uk www.midlandsurvey.co.uk

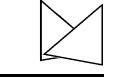

Client GEOSMART INFORMATION

Project LAND AT SIDE OF 17-20 TUDOR COURT, WALTHAMSTOW, E17 8ET

Title TOPOGRAPHICAL SURVEY

Scale 1:200@A1

Dwg No 31686/1/R1

R1-LAND AT SIDE OF 17-20 TUDOR COURT ADDED 17/07/2018

Surveyor S.T.M/J.S.P. Checked P.K.G

TOPOGRAPHICAL (LAND) SURVEYORS / UTILITY SURVEYORS BUILDING MEASUREMENT SURVEYORS / 3D LASER SCANNING







THE SURVEY ASSOCIATION constructionLine